
## MANUFACTURERS HANOVER EXTERIOR STABILIZATION

OLEAN, NY

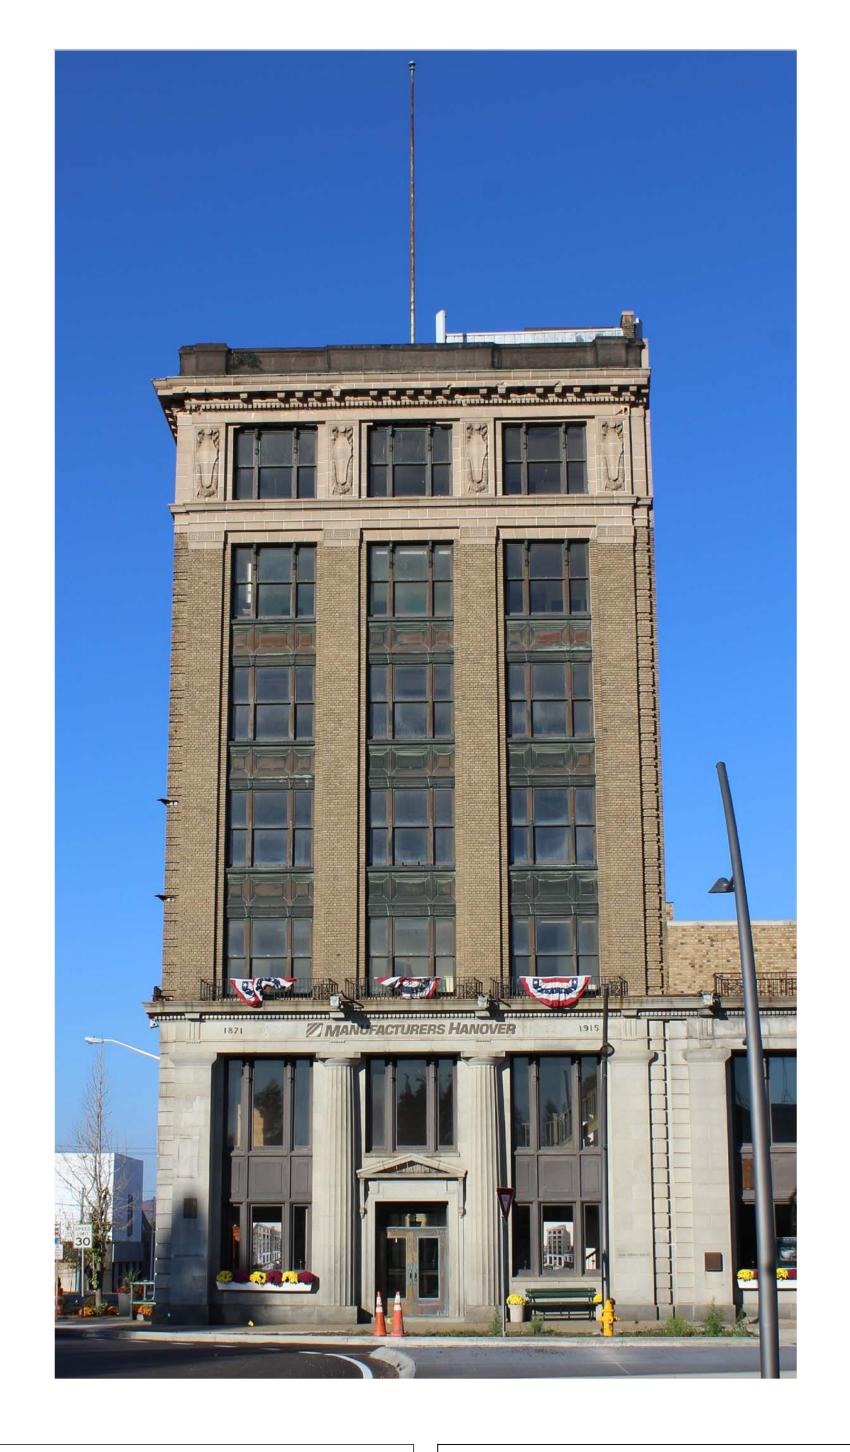

#### CONTRACTOR STAGING, STORAGE, AND PARKING



#### **CONDITION SURVEY REPORT:**

THE CONDITION SURVEY REPORT FOR THE MANUFACTURER'S HANOVER BUILDING IN OLEAN, NY COMPLETED BY VERTICAL ACCESS CAN BE FOUND AT THE DROPBOX LINK:

HTTPS://WWW.DROPBOX.COM/ sh/k859n3dae4tvffk/AAA6kuikbDzoj-N2CD-6jrJTa?dl=0

TERRACOTTA UNIT SIZES CAN BE FOUND IN THE APPENDIX AT THE BACK OF THE REPORT.

#### HISTORIC SIGNIFICANCE ACKNOWLEDGMENT

THIS PROPERTY HAS BEEN DETERMINED TO POSSESS HISTORIC AND (E.G., ARCHITECTURAL, ENGINEERING, ARTISTIC) SIGNIFICANCE AND IS LISTED IN THE NATIONAL REGISTER OF HISTORIC PLACES. THE CONTRACTOR SHALL RECOGNIZE THAT ALL ASPECTS OF THE PROPERTY MAY POTENTIALLY CONTRIBUTE TO THIS SIGNIFICANCE AND THE CONTRACTOR SHALL NOT JUDGE THE RELATIVE SIGNIFICANCE OF ANY FEATURES NOR THE IMPACT OF ANY OR ALL PROPOSED WORK. THIS RESPONSIBILITY SHALL REST SOLELY WITH THE ARCHITECT. CONSEQUENTLY NO DEVIATIONS FROM THE CONTRACT DOCUMENTS SHALL BE PERFORMED AND NO FEATURES OR MATERIALS SHALL BE ALTERED, REMOVED, REUSED, OR TAKEN FROM THE PREMISES, WITHOUT THE WRITTEN APPROVAL OF THE ARCHITECT AS BEING CONSISTENT WITH THE REQUIREMENTS OF THE CONTRACT DOCUMENTS. ALL WORK SHALL BE CONSISTENT WITH THE SECRETARY OF THE INTERIOR'S STANDARDS FOR THE TREATMENT OF HISTORIC PROPERTIES.

#### BID SHALL INCLUDE:

- PROVIDE REQUIRED PERFORMANCE ASSURANCE BONDS IN THE BID AMOUNT.
- 2. PROVIDE EQUIPMENT, LABOR, AND MATERIALS REQUIRED FOR A COMPLETE MEMBRANE REROOFING IN THIS BID.
- 3. PROVIDE EQUIPMENT, LABOR, AND MATERIALS REQUIRED FOR A COMPLETE REMOVAL OF NETTING, REPOINTING OF THE TERRACOTTA COPING, INSTALLATION OF REGLET FLASHING INTO MASONRY IN THIS BID.
- 4. PRICING OTHER THAN BASE BID SHALL BE PROVIDED ON SEPARATE ALTERNATE AND UNIT PRICE SHEETS PROVIDED IN PROJECT MANUAL.

#### LIST OF DRAWINGS

CS1 - COVER SHEET

CS2 - NOTES, ABBREVIATIONS, & SYMBOLS

A1 - ROOF PLAN

A2 - EAST & SOUTH ELEVATIONS A3 - ENLARGED ELEVATIONS

A4 - CORNICE DETAILS

#### PROJECT GOAL:

THIS IS A STABILIZATION PROJECT. THE GOAL IS TO MAKE THE PARAPET AND CORNICE WATERTIGHT AND SAFE, SO MASONRY WILL NOT FALL. PLEASE BE AWARE THAT YOUR BID NUMBERS WILL HELP THIS PROJECT RECEIVE A GRANT FOR THE REMAINDER OF THE EXTERIOR PRESERVATION WORK AT A LATER DATE.

THIS PROJECT IS RECEIVING A NYS GRANT. THE MWBE THRESHOLD GOAL FOR THIS PROJECT IS 30%. 13% MBE AND 17% WBE

#### PROVIDED BY OWNER:

THE OWNER SHALL PROVIDE CONTRACTOR WITH POWER AND WATER.

#### PARAPET & CORNICE ACCESS:

THERE IS A VAULT BELOW THE SIDEWALK ON UNION STREET/ EAST SIDE OF BUILDING. WEIGHT ON THIS PARKING LOT SHALL BE LIMITED TO THAT SPECIFIED BY CITY ENGINEER.

CONTRACTORS SHALL SHARE SCAFFOLDING AND LIFTS TO SAVE MONEY FOR OWNER WHENEVER POSSIBLE.

CONTRACTORS WILL NEED TO APPLY FOR A PERMIT TO SHUT DOWN OR PROTECT PEDESTRIAN SIDEWALK DURING CONSTRUCTION. THE PERMIT WILL BE FREE FOR THIS PROJECT.

#### DIGITAL PROJECT DOCUMENTS:

DIGITAL PROJECT DOCUMENTS ARE AVAILABLE. HARD COPIES ARE THE RESPONSIBILITY OF CONTRACTOR.

#### A LINK CAN BE FOUND AT:

https://www.dropbox.com/ sh/tu2of25msym2kbb/AAB0qM5voBkTn71yUD3wth9Ha?dl=0

#### ASBESTOS CONTAINING MATERIAL (ACM):

ACM HAS BEEN IDENTIFIED AS THE BLACK BITUMEN ON THE COPING JOINTS AND THE SILVER COATING ON THE INSIDE OF THE PARAPET WALL. ACM SHALL BE REMEDIATED BY THE ROOFING CONTRACTOR LICENSED TO DO SO IN THE STATE OF NEW YORK.

A LINK CAN BE FOUND AT:

https://www.dropbox.com/

s/swx2vlc0m8hslon/ManfrHanoverRoof\_AsbestosReport%284-26-17%29.pdf?dl=0

#### **CONTRACT NOTES:**

- 1. THIS IS A PREVAILING WAGE RATE PROJECT.
- 2. CONTRACTORS SHALL NOT PERFORM WORK DIFFERENT THAN DRAWINGS AND SPECIFICATIONS WITHOUT FIRST RECEIVING WRITTEN PERMISSION FROM ARCHITECT. IF CONTRACTOR DOES NOT RECEIVE WRITTEN PERMISSION FROM ARCHITECT AND A CHANGE IS REQUIRED THEY AGREE TO MAKE THE CHANGE AT THEIR OWN EXPENSE.



15 EAST MARKET ST CORNING, NY 14830 phone (607) 937-1946

SEAL:

CONSULTANT:

SURVEYED USING tpas®
SURVEY DATE: NOVEMBER 10-11, 2016
BY: PC, KDA, EK
PO BOX 4135
ITHACA, NY 14852
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PROJECT:

MANUFACTURERS
HANOVER EXTERIOR
STABILIZATION

DRAWING TITLE:

REVISIONS:

ISSUED FOR BID

SCALE: AS NOTED

DATE: 05-18-20

REVIEWED: DJA

DRAWN: CAD

PROJECT NO: 1609

DRAWING NO:

CS1

# WALL SYMBOLS PROPOSED WALL REINFORCED CMU REINFORCED CONCRETE EXISTING WALL DEMOLISHED WALL

TYPICAL SYMBOLS							
ROOM NAME, NUMBER, SIZE	OFFICE A101 269 SF						
ELEVATION	4 A0.00 2 QA0.00						
WALL/DETAIL SECTION	0 A0.00						
BUILDING SECTION	0 A0.00						
DETAIL/ TITLE NUMBER	0 A0.00						
CUTLINE							
DOOR MARK	(A101-1)						
WINDOW MARK	⟨A⟩						
ELEVATION INDICATION	+1000'-0"						
SLOPE	6:12						

MATERIAL	SYMBOLS
EARTH/ COMPACT FILL	
POROUS FILL/ GRAVEL	
CONCRETE	The second secon
BRICK	
CONCRETE MASONRY	
STEEL	
FINISH WOODWORK	
ROUGH CARPENTRY	
BLOCKING	
PLYWOOD	
GYPSUM WALL BOARD	
BATT INSULATION	
RIGID INSULATION	
CARPET	
VINYL COMPOSITE	
BAFFLE	

#### **ABBREVIATIONS**

ADDREVIATIONS									
&	AND	ENC	ENCLOSE, ENCLOSURE	MACH	MACHINE	SC	SOLID CORE		
ABV A/C	ABOVE AIR CONDITIONING	ENG ENT	ENGINEER (ING) ENTRANCE	MAH MAINT	MAHOGANY MAINTANENCE	SCH SCN	SCHEDULE SCREEN		
ACT	ACCOUSTIC TILE	EQ	EQUAL	MAS	MASONRY	SD	SMOKE DETECTOR		
ACW	ALUMINUM CLAD WOOD	EQPM	EQUIPMENT	MATL	MATERIAL	SECT	SECTION		
ADJ ADD	ADJUSTABLE ADDENDUM	EST EXC	ESTIMATE (D) EXCAVATE	MAX MECH	MAXIMUM MECHANICAL	SF SFR	SQUARE FOOT STORE FOR REUSE		
ADH	ADHESIVE	EXG	EXISTING	MED	MEDIUM	SH	SILL HEIGHT		
ADJ	ADJACENT	EXH	EXHAUST	MDF	MEDIUM DENSITY FIBERBOARD	SHTG	SHEATHING		
ADO AFF	AUTOMATIC DOOR OPENER ABOVE FINISHED FLOOR	EXP EXT	EXPOSED EXTERIOR	MDO MIN	MEDIUM DENSITY OVERLAY MINIMUM	SHWR SIM	SHOWER SIMILAR		
AGG	AGGREGATE	EBCNYS	EXISTING BUILDING CODE	MIR	MIRROR	SKL	SKYLIGHT		
ALT	ALTERNATE		OF NEW YORK STATE	MGMT	MANAGEMENT	SL	SLIDING		
ALUM ANC	ALUMINUM	Γ.Δ	FIRE ALARM	MLD MMB	MOULDING MEMBRANE	SLNT	SEALANT		
APPROX	ANCHOR (AGE) APPROXIMATE	FA FAB	FABRICATE	MO	MASONRY OPENING	SP SPEC	SOUND PROOF SPECIFICATION (S)		
ARCH	ARCHITECT (URAL)	FB	FACE BRICK	MOD	MODULAR	SPKR	SPEAKER		
AT AVG	@ ^\/FD^CF	FBD FBO	FIBERBOARD FINISHED BY OTHERS	MNT MTL	MOUNT (ED), MOUNTING METAL	SS ST	STAINLESS STEEL		
AWN	AVERAGE AWNING	FE	FIRE EXTINGUSHER	MUL	MULLION	STL	STREET STEEL		
AUX	AUXILIARY	FF	FINISH FLOOR			STN	STAIN (ED)		
DONN/O	DI III DINO CODE CE NEW VODY CTATE	FG	FIBERGLASS	NA	NOT AVAILABLE, NOT APPLICABLE	STND	STANDARD		
BCNYS BEL	BUILDING CODE OF NEW YORK STATE BELOW	FIG FIN	FIGURE FINISH (ED)	NEG NIC	NEGATIVE NOT IN CONTRACT	STOR STR	STORAGE STRUCTURAL		
BEV	BEVELED	FLR	FLOOR (ING)	NO	NUMBER	SUP	SUPPLY		
BF	BOARD FEET	FND	FOUNDATION	NOM	NOMINAL	SUR	SURFACE		
BL BLDG	BUILDING LINE BUILDING	FLASH FO	FLASHING FACE OF	NTS	NOT TO SCALE	SHT SQ	SHEET SQUARE		
BLK	BLOCK	FPL	FLOOR PLATE	OA	OVERALL	SW	SWITCH (ED)		
BLKG	BLOCKING	FR	FRAME, FRAMED, FRAMING	OBS	OBSCURE	SYS	SYSTEM		
BO BOF	BOTTOM OF BOTTOM OF FOOTING	FS FT	FRAME SIZE	OC OD	ON CENTER OUTSIDE DIMENSION	Т	TREAD		
BOT	BOTTOM	FTG	FEET, FOOT, ' FOOTING	O/H	OVERHEAD	т&В	TOP & BOTTOM		
BOP	BOTTOM OF PIT	FURN	FURNITURE	ОН	OVERHANG	T&G	TONGUE & GROOVE		
BPL	BEARING PLATE	FXT	FIXTURE (S)	OPNG	OPENING	TBD	TO BE DETERMINED		
BRD BRG	BOARD BEARING	GA	GAUGE	OPP ORIG	OPPOSITE ORIGINAL	TEL TEMP	TELEPHONE TEMPORARY, TEMPERATURE		
BRK	BRICK	GALV	GALVANIZED			TH	THICKNESS		
BRM	BEDROOM	GC	GENERAL CONTRACTOR	PAR	PARALLEL	THR	THRESHOLD		
BS	BOTH SIDES	GD GL	GRADE, GRADING GLASS, GLAZING	PART PBRD	PARTITION PARTICLE BOARD	THRU TL	THROUGH TILE		
CAB	CABINET	GVL	GRAVEL	PC	POWDER COAT	TOF	TOP OF FOOTING		
CC	CENTER TO CENTER	GWB	GYPSUM WALL BOARD	PCC	PRECAST CONCRETE	TOJ	TOP OF JOIST		
CD CEM	CONSTRUCTION DOCUMENT CEMENT	GYP	GYPSUM	PEN PERF	PENETRATION PERFORATED	TOM TOS	MASONRY TOP OF SLAB		
CH	CHANNEL	НВ	HOSE BIB	PERI	PERIMETER	TOW	TOP OF SLAB TOP OF WALL		
CIP	CAST IN PLACE CONCRETE	HC	HOLLOW CORE	PERM	PERMANENT	TV	TELEVISION, CABLE		
CIR	CIRCLE	HC	HANDICAP	PERP	PERPENDICULAR	TYP	TYPICAL		
CL CLAD	CENTERLINE ALUMINUM CLAD	HD BD HDO	HARDBOARD HIGH DENSITY OVERLAY	PFN PKG	PREFINISHED PARKING	TZ	TERRAZZO		
CLG	CEILING	HDR	HEADER	PKWY	PARKWAY	UNEXC	UNEXCAVATED		
CLK	CAULK(ING)	HDW	HARDWARE	P	PLUMBING	UNF	UNFINISHED		
CLR CL,CLOS	CLEAR (ANCE) CLOSET	HD WD HM	HARDWOOD HOLLOW METAL	PL PLT	PROPERTY LINE PLATE	UNO UNP	UNLESS NOTED OTHERWISE UNPAINTED		
CMU	CONCRETE MASONRY UNIT	HOR	HORIZONTAL	PLAST	PLASTER	ONE	ONFAINTED		
COL	COLUMN	HT	HEIGHT	PLS	PLASTIC	VAT	VINYL ASBESTOS TILE		
CON CONC	CONNECTION, CONNECTOR CONCRETE	HTG HTR	HEATING HEATER	PLYWD PNT (D)	PLYWOOD PAINT (ED)	VCT VENT	VINYL COMPOSITION TILE VENTILATING		
	CONCRETE BLOCK	HVAC	HEATING, VENTILATION	POL	POLISHED	VERT	VERTICAL		
CONST	CONSTRUCTION		& AIR CONDITIONING	POS	POSITIVE	VEST	VESTIBULE		
CONT CONTR	CONTINUOUS(UATION)	HW	HOT WATER	PNL PR	PANEL PAIR	VIF	VERFIFY IN FIELD		
COMP	CONTRACT (OR) COMPACTED	ID	IDENTIFICATION	PROJ	PROJECT	W	WIDTH		
COORD	COORDINATE	IN	INCH (ES), "	PROP	PROPERTY	W/	WITH		
CS	COVER SHEET	INCL	INCLUDE (D), INCLUDING INFORMATION	PSF PSI	POUNDS PER SQUARE FOOT POUNDS PER SQUARE INCH	W/O WB	WITHOUT		
CSMT CT	CASEMENT CERAMIC TILE	INFO INS	INSERT	PT	PRESSURE TREATED	WC	WOOD BASE TOILET, WATER CLOSET		
CTR	COUNTER	INSUL	INSULATE, INSULATED, INSULATION	PUR	POLYURETHANE	WD	WOOD		
	DENIAN/	INSMTL	INSULATED METAL	PV	PAVE (D), PAVING	WP	WATER PROOFING		
d DBL	PENNY DOUBLE	INT INTERM	INTERIOR INTERMEDIATE	PVC PWR	POLYVINYL CHLORIDE POWER	WSCT WT	WAINSCOT WEIGHT		
DEG	DEGREE					WTW	WALL TO WALL		
DEMO	DEMOLITION	JNT	JOINT	QTY	QUANTITY	WWF	WELDED WIRE FABRIC		
DH DIA	DOUBLE HUNG DIAMETER	JST	JOIST	R	RISER	YD	YARD		
DIAG	DIAGONAL	L	LENGTH	RAD,R		YR	YEAR		
DIM	DIMENSION	LAM	LAMINATE (D)	RBR	RUBBER				
DIV DN	DIVISION DOWN	LAT LAV	LATERAL LAVATORY	RC REF	REINFORCED CONCRETE REFERENCE, REFRIGERATOR				
DN DR	DOOR	LED	LIGHT EMITTING DIODE	REIN	REINFORCING				
DS	DOWNSPOUT	LF	LINEAR FOOT	RM	ROOM				
DTL	DETAIL	LGMF	LIGHT GAUGE METAL FRAMING	REQ	REQUIRE, REQUIRED				
DWG DW	DRAWING DISHWASHER	L <b>I</b> N LS	LINEAR LANDSCAPE	RET REV	RETAINING REVISION				
EA	EACH	LT	LIGHT	RFG	ROOFING				
EIFS	EXTERIOR INSULATED FASCIA SYSTEM	LTG	LIGHTING	RMV	REMOVE				
EL ELEC	ELEVATION ELECTRICAL	LTL LVR	LINTEL LOUVER	RO ROW	ROUGH OPENING RIGHT OF WAY				
ELEV	ELECTRICAL ELEVATOR	LVIX	LOOVEIX	RTE	ROUTE				
EMER	EMERGENCY	MANUF	MANUFACTURER						

#### **GENERAL NOTES**

- 1. CONTRACTOR SHALL VERIFY ALL DIMENSIONS IN THE FIELD. NOTIFY THE ARCHITECT IF ANY ADDITIONAL DIMENSIONS ARE REQUIRED.
- 2. CONTRACTOR SHALL VERIFY ON SITE ALL EXISTING CONDITIONS PRIOR TO STARTING WORK. NOTIFY ARCHITECT OF ANY DISCREPANCIES THAT AFFECT WORK.
- 3. CONTRACTOR SHALL COORDINATE THEIR WORK WITH WORK OF ALL OTHER CONTRACTORS AND THE OWNER PRIOR TO STARTING THE WORK.
- 4. CONTRACTOR SHALL BE RESPONSIBLE FOR PROVIDING A WATERTIGHT AND WEATHER-TIGHT EXTERIOR ENVELOPE WHERE THERE IS NEW CONSTRUCTION & WHERE NEW CONSTRUCTION MEETS THE EXISTING ENVELOPE.
- 5. DIMENSIONS TAKEN FROM SURFACE OF SHEATHING; UNLESS OTHERWISE NOTED.
- 6. CONTRACTOR SHALL INSTALL PRODUCTS COMPLETE, IN WORKING ORDER AND ACCORDING TO THE MANUFACTURER'S INSTRUCTIONS.
- 7. CONTRACTOR SHALL SECURE ALL PRODUCTS IN PLACE WITH POSITIVE ANCHORAGE DEVICES DESIGNED AND SIZED TO WITHSTAND STRESSES, VIBRATION, PHYSICAL DISTORTION, AND DISFIGUREMENT.
- 8. CONTRACTOR SHALL KEEP INCOMPATIBLE MATERIALS APART FROM EACH OTHER.
- 9. CONTRACTORS SHALL PROVIDE SUBMITTALS FOR ALL PRODUCTS.
- 10. CONTRACTOR SHALL COMPLY WITH ALL FEDERAL, STATE, AND LOCAL CODES.
- 11. CONTRACTOR SHALL PROTECT ALL EXISTING AND INSTALLED PRODUCTS FROM DAMAGE.
- 12. CONTRACTOR SHALL PROVIDE A SEAMLESS TRANSITION WHERE NEW WORK MEETS EXISTING ADJACENT WORK; UNLESS OTHERWISE NOTED.
- 13. CONTRACTOR SHALL LEAVE THE PROJECT SITE CLEAN OF DEBRIS, DUST, AND DAMAGE.
- 14. CONTRACTOR MAY SUBSTITUTE SPECIFIED MANUFACTURER NOTED IF SAID SUBSTITUTION IS EQUAL OR GREATER THAN SPECIFIED.
- 15. IF THERE IS A DISCREPANCY BETWEEN ARCHITECTURAL, SITE, STRUCTURAL, MECHANICAL, ELECTRICAL, PLUMBING, AND/ OR FIRE PROTECTION DRAWINGS, CONTACT ARCHITECT IMMEDIATELY.

#### DEFINITIONS:

- 1. INSTALL: TO UNPACK, ASSEMBLE, ERECT, APPLY, PLACE, FINISH, CURE, PROTECT, CLEAN, START UP, AND MAKE READY FOR USE.
- 2. PRODUCT: MATERIAL, MACHINERY, COMPONENTS, EQUIPMENT, FIXTURES, AND SYSTEMS FORMING THE WORK RESULT. NOT MATERIALS OR EQUIPMENT USED FOR PREPARATION, FABRICATION, CONVEYING, OR ERECTION AND NOT INCORPORATED INTO THE WORK RESULT. PRODUCTS MAY BE NEW, NEVER BEFORE USED, OR RE-USED MATERIALS OR EQUIPMENT.
- 3. PROVIDE: TO FURNISH AND INSTALL.
- 4. SUPPLY: SAME AS PROVIDE.
- 5. COMPLETE: LACKING NOTHING; HAVING ALL NECESSARY PARTS, ELEMENTS OR STEPS.
- 6. TYPICAL: ITEM/ PRODUCT SAME FOR ENTIRE PROJECT; UNLESS OTHERWISE NOTED.



15 EAST MARKET ST CORNING, NY 14830 phone (607) 937-1946

SEAL:

CONSULTANT:

SURVEYED USING tpas®

SURVEY DATE: NOVEMBER 10-11, 2016
BY: PC, KDA, EK
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ITHACA, NY 14852
607.257.4049 WWW.VERTICAL-ACCESS.COM

PROJECT:

MANUFACTURERS
HANOVER EXTERIOR
STABILIZATION

DRAWING TITLE:
NOTES,
ABBREVIATIONS,
& SYMBOLS

REVISIONS:

ISSUED FOR BID

SCALE: AS NOTED

DATE: 05-18-20


DRAWN: CAD

PROJECT NO: 1609

REVIEWED: DJA

DRAWING NO:

<u> 2</u>S2

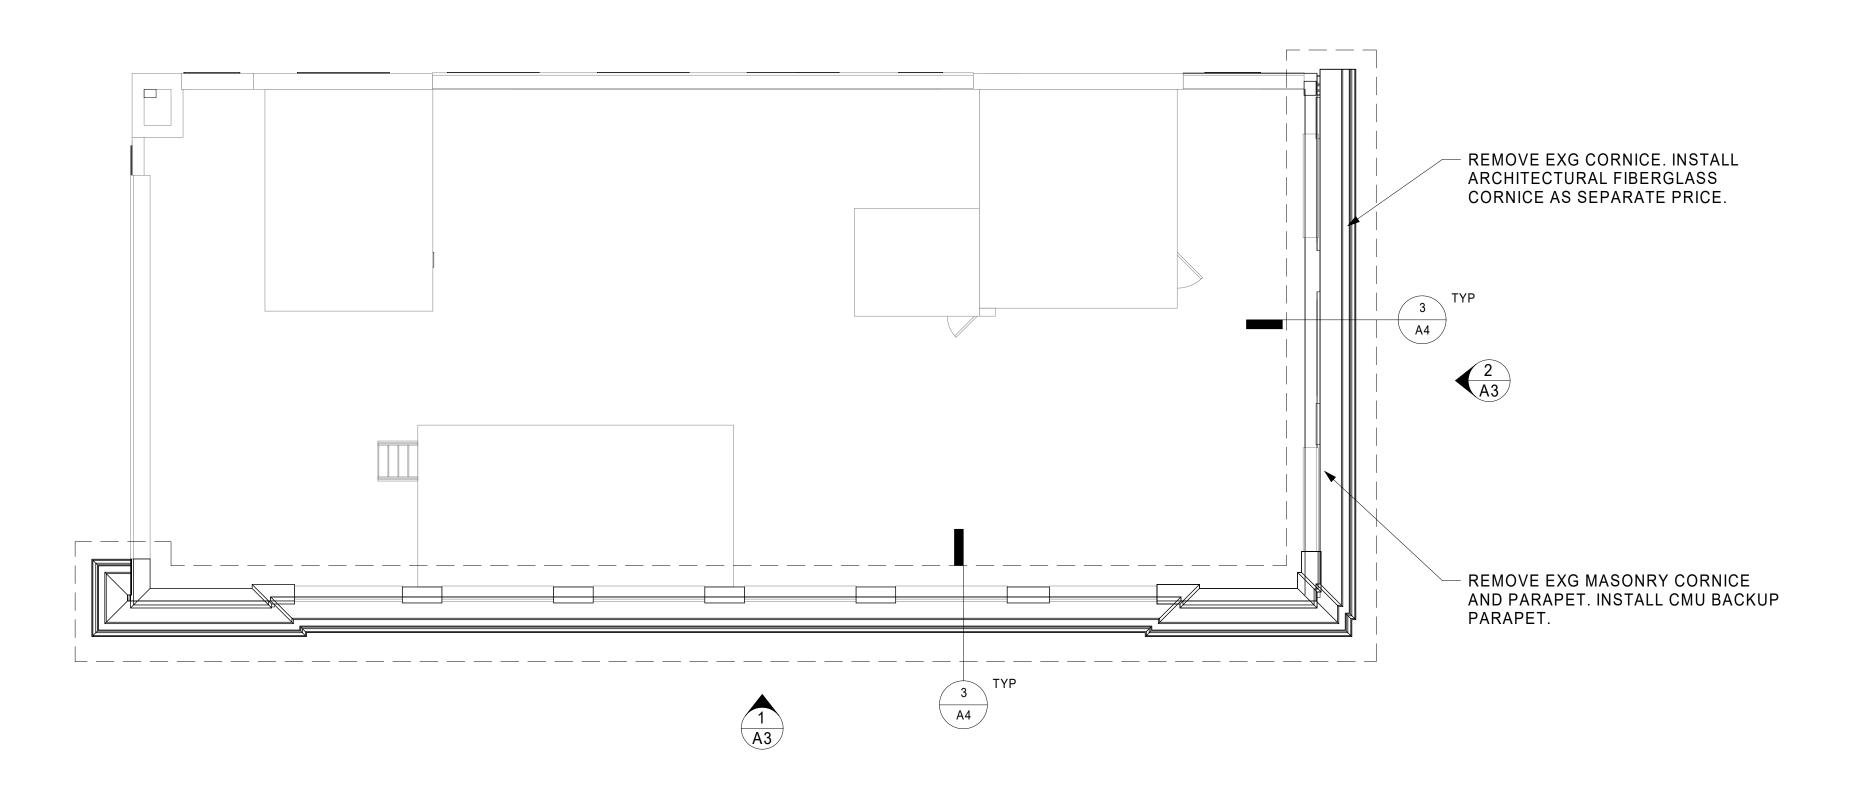

1 ROOF PLAN
1/8" = 1'-0"



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SEAL:

CONSULTANT:

PROJECT: MANUFACTURERS HANNOVER

101 NORTH UNION, OLEAN, NY 14760

DRAWING TITLE: ROOF PLAN

REVISIONS: ISSUED FOR BID

SCALE: AS NOTED

DATE: 5/19/2020

DRAWN BY: Author

REVIEWED BY: Checker

DRAWING NO:



JOHNSON:
SCHMIDT
AND
ASSOCIATES
ARCHITECTS

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ROJECT:

MANUFACTURERS HANOVER EXTERIOR STABILIZATION

DRAWING TITLE:
EAST & SOUTH
ELEVATIONS

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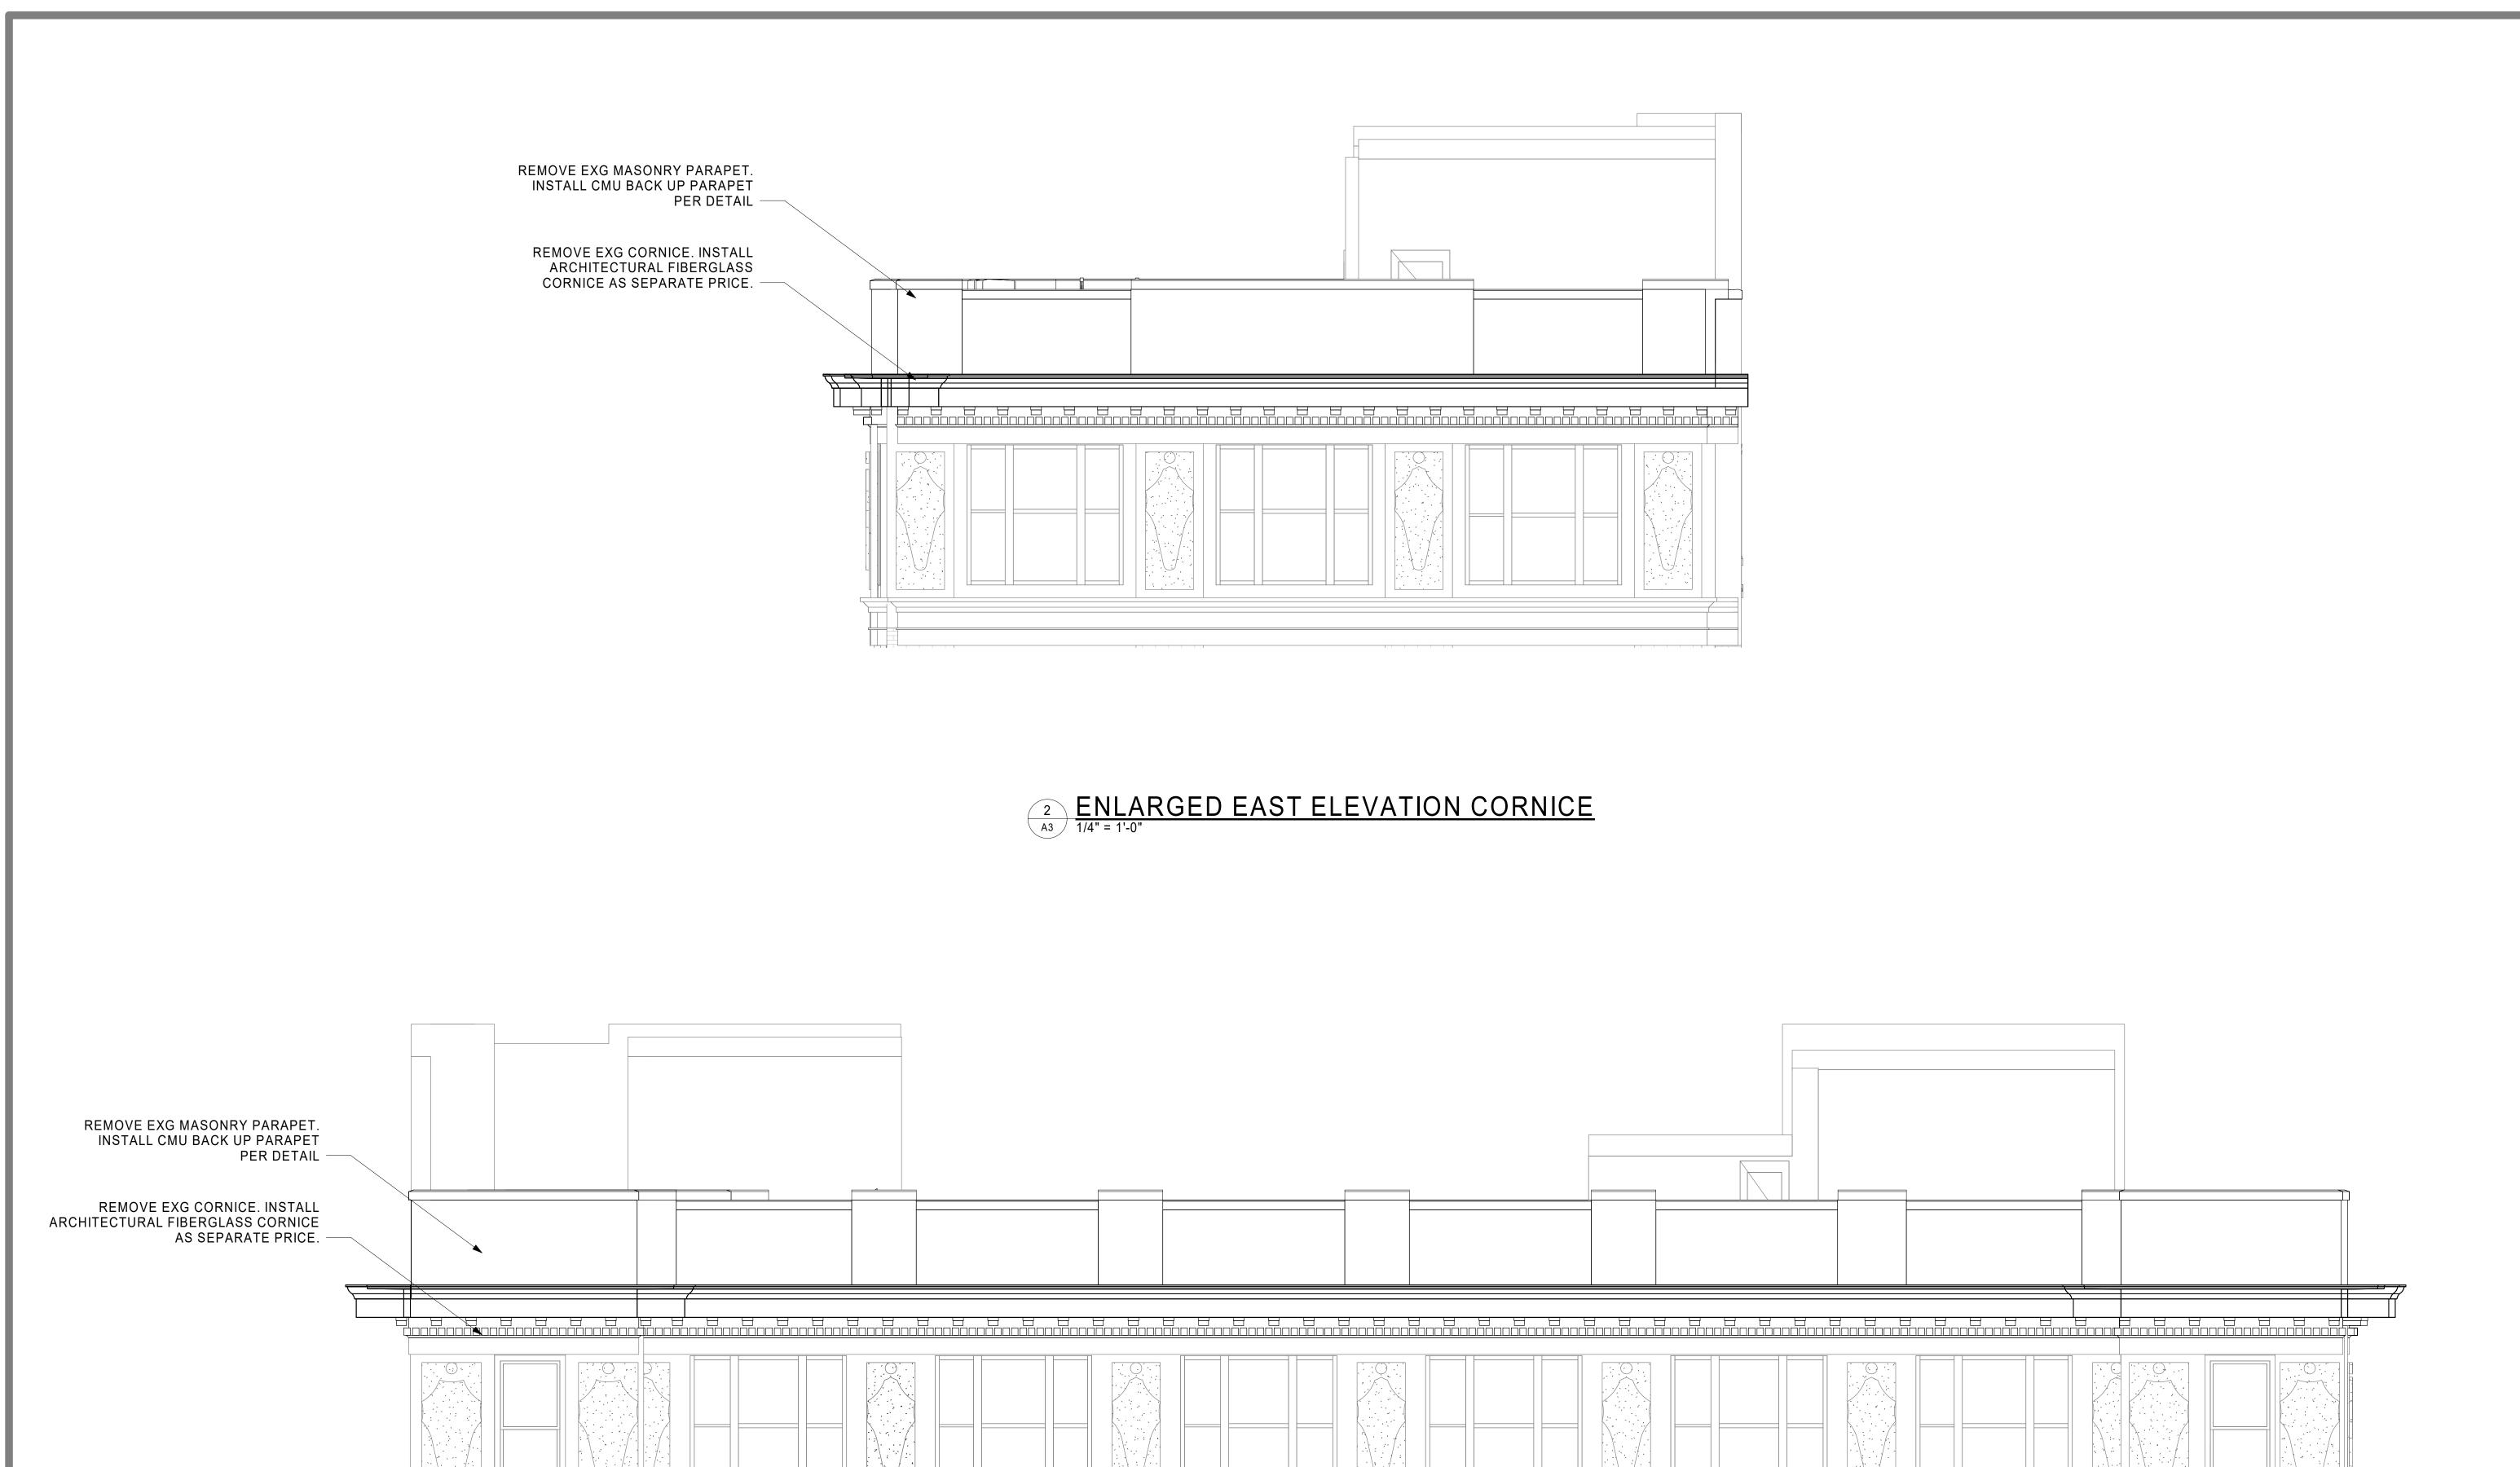
DRAWN: CAD

NOTE: DRAWINGS ARE DESIGNED TO BE PRINTED IN COLOR.

REVIEWED: DJA

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ENLARGED SOUTH ELEVATION CORNICE

A3 1/4" = 1'-0"

JOHNSON:
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AND
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15 EAST MARKET ST

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SEAL:

CONSULTANT:

PROJECT: MANUFACTURERS HANNOVER

101 NORTH UNION, OLEAN, NY 14760

DRAWING TITLE: ENLARGED ELEVATIONS

REVISIONS: ISSUED FOR BID


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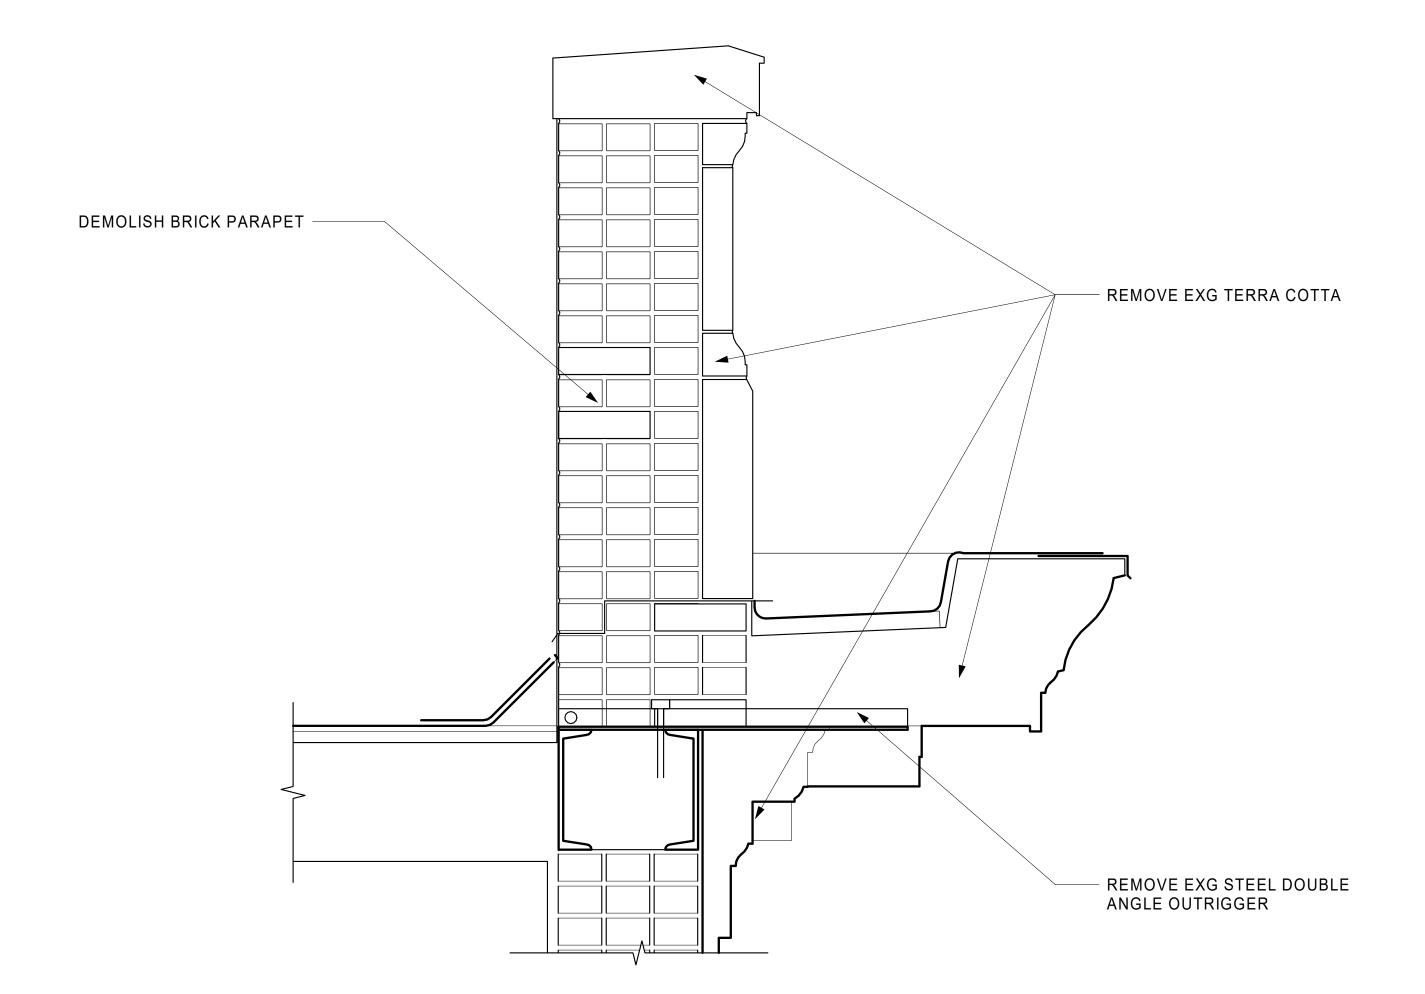
REVIEWED BY: DJA

DRAWING NO:



### NOTE:

BLOCKING AND FIBERGLASS SHOWN FOR REFERENCE ONLY. ARCHITECTURAL FIBERGLASS INSTALLER IS RESPONSIBLE FOR PROFILE AND FINISH OF MOLDED FIBERGLASS CORNICE AND BLOCKING DESIGN.

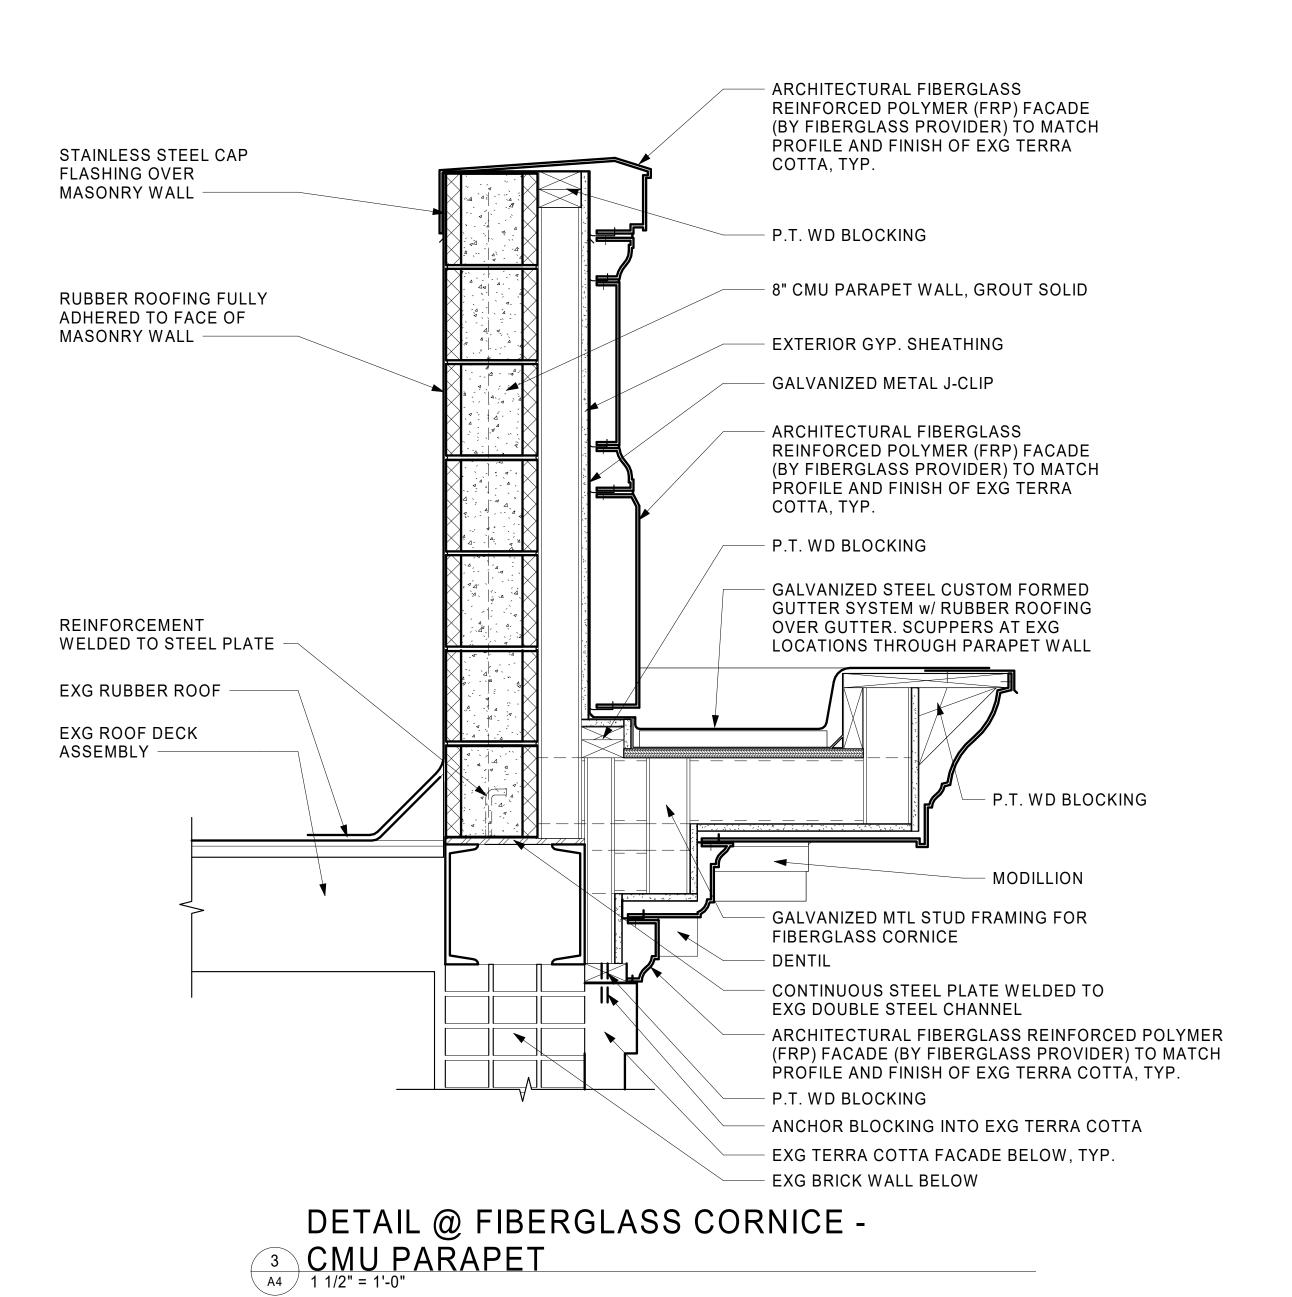

1 DETAIL @ EXG CORNICE
A4 1 1/2" = 1'-0"



15 EAST MARKET ST CORNING, NY 14830 PHONE: (607) 937-1946

CONSULTANT:



PROJECT: MANUFACTURERS HANNOVER

101 NORTH UNION, OLEAN, NY 14760

DRAWING TITLE: CORNICE AND PARAPET DETAILS

REVISIONS:

SCALE: AS NOTED

DATE: 5/19/2020

DRAWN BY: DGR

REVIEWED BY: DJA

DRAWING NO: